DRAWING LIST

- CAMPUS SITE PLAN
- FLOOR PLANS

- TITLE SHEET
- ENLARGED SITE PLAN
- EXTERIOR ELEVATIONS

ABBREVIATIONS							
A.F.F.	•	ABOVE FINISHED FLOOR	LVL	•	LAMINATED VENEER LUMBER		
ACOU.	•	ACOUSTICAL	M.H.	•	MANHOLE		
ALUM.	•	ALUMINUM	M.O.	•	MASONRY OPENING		
ARCH.	•	ARCHITECT	MAX.	•	MAXIMUM		
@ P./O	•	AT BOTTOM OF	MECH. MFR.	•	MECHANICAL		
B/O BLDG.	•	BUILDING	MIN.	:	MANUFACTURER MINIMUM		
BLBO. BLK.		BLOCK	MISC.		MISCELLANEOUS		
BOT.		BOTTOM	MTL.	•	METAL		
C.D.	•	CONSTRUCTION DOCUMENTS	N.I.C.	•	NOT IN CONTRACT		
C.H.	•	CEILING HEIGHT (FINISHED)	N.T.S.	•	NOT TO SCALE		
CAB	•	CABINET	NO.	•	NUMBER		
СВ	•	CATCH BASIN	NOM.	•	NOMINAL		
CIP	•	CAST IRON PIPE	O.A.	•	OVERALL		
€ C1	•	CONTROL JOINT CENTERLINE	O.C. O.H.	•	ON CENTER		
۷ CLG		CEILING	О.п. ОН		OVERHANG		
CLG CLO.		CLOSET	OPG	•	OVERHEAD OPENING		
CLO.		CLEAR	OPP	•	OPPOSITE		
CMU	•	CONCRETE MASONRY UNIT	P.L.		PROPERTY LINE		
CO	•	CLEAN OUT	PART.	•	PARTITION		
COL.	•	COLUMN	PERP.	•	PERPINDICULAR		
CONC.	•	CONCRETE	PLWD.	•	PLYWOOD		
CONST.	•	CONSTRUCTION	POLY	•	POLYETHYLENE		
CONT.	•	CONTINUOUS	PSF	•	POUNDS/SQUARE FOOT		
CT	•	CERAMIC TILE	PSI	•	POUNDS/SQUARE INCH		
D/W	•	DISHWASHER	PSL	•	PARALLEL STRAND LUMBER		
DBL. DEMO	•	DOUBLE DEMOLITION	PT PVC	•	PRESSURE TREATED POLYVINYLCHLORIDE		
DEMO DET.	•	DETAIL	QTY.	•	QUANTITY		
DIA.	•	DIAMETER	R	•	RADIUS		
DIAG.	•	DIAGONAL	R.D.	•	ROOF DRAIN		
DIM.	•	DIMENSION	R.O.	•	ROUGH OPENING		
DL	•	DEAD LOAD	R.O.W.	•	RIGHT OF WAY		
DN.	•	DOWN	RE BAR	•	REINFORCING BAR		
DR	•	DOOR	REF.	•	REFRIGERATOR		
DWG. E.I.F.S.	•	DRAWING EXTERIOR INSULATION &	REINF.	•	REINFORCED		
L.I.I .J.	•	FINISH SYSTEMS	REQ'D REV.	•	REQUIRED REVISION		
EA.	•	EACH	REV. RM	•	ROOM		
ELEC.	•	ELECTRIC	ROB	•	RUN OF BANK		
ELEV.	•	ELEVATION	S.D.	•	SMOKE DETECTOR		
EPDM	•	ETHYLENE PROPYLENE	SAC	•	SUSPENDED ACOUSTICAL		
	•	DIENE MONOMER			CEILING		
EQ.	•	EQUAL	SECT.	•	SECTION		
EQUIP.	•	EQUIPMENT	SIM.	•	SIMILAR		
EXIST.	•	EXISTING	SPECS	•	SPECIFICATIONS		
EXT.	•	EXTERIOR	SQ. FT.	•	SQUARE FEET		
F.E. F.D.	•	FIRE EXTINGUISHER FLOOR DRAIN	SQ. IN. STL.	•	SQUARE INCHES STEEL		
FIN.	•	FINISH	STD.	•	STANDARD		
FIN. FL.	•	FINISH FLOOR	STOR	•	STORAGE		
FL	•	FLOOR	SUSP.	•	SUSPENDED		
FOUND.	•	FOUNDATION	SYS.	•	SYSTEM		
FTG.	•	FOOTING	T&G	•	TONGUE & GROOVE		
GA.	•	GAUGE	T/O	•	TOP OF		
GAL	•	GALLON	TYP.	•	TYPICAL		
GALV.	•	GALVANIZED	V.B.	•	VAPOR BARRIER		
GFI GWB	•	GROUND FAULT INTERRUPTER	V.C.T. V C B		VINYL COMPOSITE TILE		

GYPSUM WALL BOARD

HEATING, VENTILATING

AND AIR CONDITIONING

HOLLOW METAL

HANDICAP

INSULATION

INTERIOR

KITCHEN

LAVATORY

HORIZONTAL

H.M.

LIN.

V.C.B. • VINYL COVE BASE

V.T. • VINYL TILE

W/ • WITH

WT. • WEIGHT

V.I.F. • VERIFY IN FIELD VERTICALLY

W.C. • WATER CLOSET

WOOD

YARD


W.P. • WEATHER PROOF

W.W.M. • WELDED WIRE MESH

GENERAL NOTES

- 1. ALL WORK SHALL CONFORM TO 2022 CONNECTICUT STATE BUILDING CODE AS WELL AS ALL OTHER APPLICABLE CODES AND ORDINANCES.
- CONTRACTOR(S) IS TO REQUEST CLARIFICATION FROM THE ARCHITECT REGARDING ANY ERRORS, OMISSIONS, OR DISCREPANCIES, IF ANY, FOUND IN THE CONSTRUCTION DOCUMENTS BEFORE PROCEEDING WITH THE SAID WORK.
- 3. NO DRAWING IS TO BE SCALED; USE DIMENSIONS ONLY.
- 4. DIMENSIONS ARE TAKEN FROM FACE OF MASONRY/CONCRETE OR WOOD MEMBERS UNLESS OTHERWISE INDICATED.
- 5. CONTRACTOR(S) IS TO OBTAIN AND PAY FOR ALL REQUIRED LOCAL PERMITS BEFORE WORK CAN COMMENCE.
- 6. ITEMS NOT NOTED, BUT IMPLIED AS NECESSARY FOR THE PERFORMANCE OF THE CONTRACT, ARE CONSIDERED PART OF THE WORK
- 7. ALL MATERIAL AND WORKMANSHIP IS TO BE GUARANTEED BY THE CONTRACTOR TO BE FREE FROM DEFECTS FOR A PERIOD OF ONE YEAR AFTER THE ISSUANCE OF A VALID CERTIFICATE OF OCCUPANCY. THE CONTRACTOR AGREES TO CORRECT ANY DEFECTS AS MAY OCCUR DURING THE GUARANTEE PERIOD.
- 8. ALL WORK IS TO BE EXECUTED BY MECHANICS SKILLED IN THEIR TRADES.
- 9. ALL CHANGES OR SUBSTITUTIONS ARE TO BE APPROVED BY THE OWNER IN WRITING BEFORE BEING INCORPORATED INTO
- 10. ALL TRADES WILL COOPERATE WITH EACH OTHER TO FACILITATE THE PROGRESS OF THE ENTIRE JOB.
- 1 1. CONTRACTOR(S) IS TO PROTECT THE PUBLIC AND PREMISES DURING THE PERIOD OF CONSTRUCTION WITH ADEQUATE SHORING, BRACING, FENCING, LIGHTING. ETC.
- 12. CONTRACTOR(S) IS TO REMOVE ALL RUBBISH FROM THE SITE RESULTING FROM HIS/HER WORK DURING THE PROGRESS OF CONSTRUCTION AND SHALL LEAVE THE PREMISES IN A CONDITION SATISFACTORY TO THE OWNER PRIOR TO THE FINAL PAYMENT.
- 13. ALL FOOTINGS TO BEAR ON UNDISTURBED SOIL MINIMUM 4'-0" BELOW FINISHED GRADE, UNLESS BEARING ON SOLID ROCK IS ESTABLISHED.
- 14. CONFIRM ALL EXISTING CONDITIONS BEFORE PROCEEDING WITH THE SAID WORK.
- 15. CONFORM TO ALL MANUFACTURERS INSTRUCTIONS AND SPECIFICATIONS FOR THE INSTALLATION OR USE OF ALL MATERIALS UNLESS OTHERWISE NOTED.
- 16. PITCH FINISH GRADE AWAY FROM STRUCTURE.
- 17. ALL CONSTRUCTION IS NEW UNLESS INDICATED AS EXISTING.
- 18. STUD BEARING WALLS AND ROOF AND FLOOR DECKS SHALL BE FRAMED WITH THE MEMBER SIZES AND/OR TYPES AT THE SPACING SHOWN ON THE PLANS. THE CONTRACTOR SHALL COORDINATE LOCATIONS OF ALL PLUMBING PIPING, HVAC DUCTING AND RECESSED LIGHTING FIXTURES, ETC., PRIOR TO LAYOUT TO AVOID INTERFERENCE THAT MAY REQUIRE THE ALTERING OR STRENGTHENING OF THE INSTALLED FRAMING.

SYMBOLS

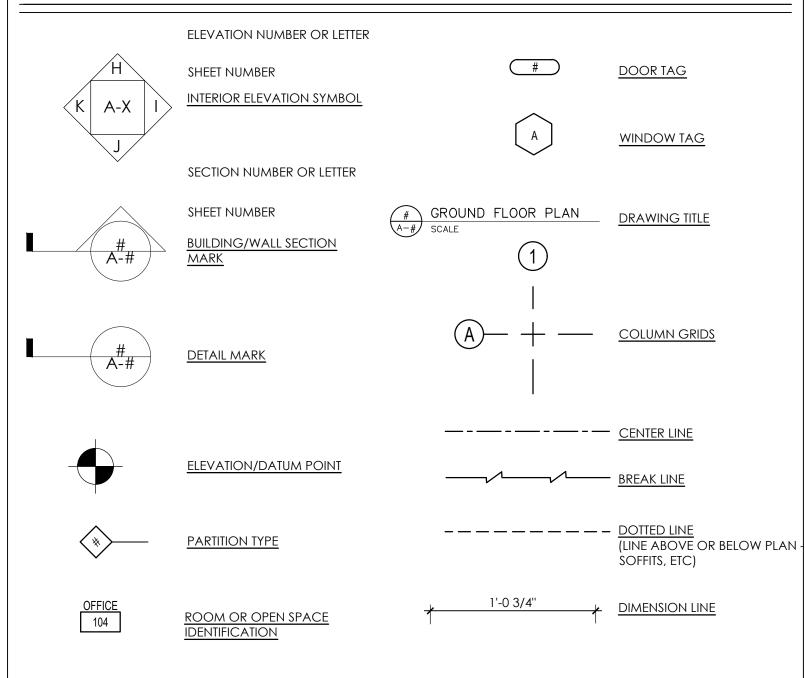


MATERIAL LEGEND

STONE GRAVEL	WOOD BLOCKING
CONCRETE	CONTIUOUS WOOD FRAMING
CONCRETE BLOCK	FINISH WOOD
BRICK	PLYWOOD
RIGID INSULATION	BATT INSULATION
GYPSUM WALLBOARD PARTITION	STEEL

PROJECT DATA



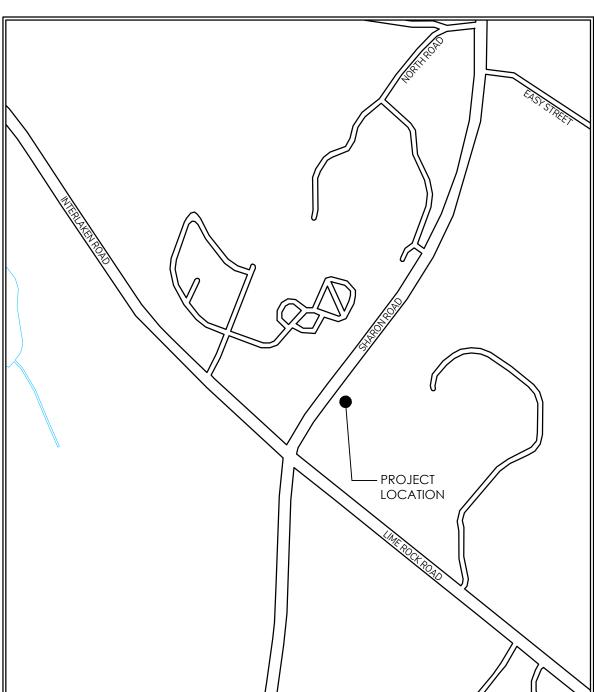

CLASSIFICATION: OCCUPANCY R - RESIDENTIAL CONSTRUCTION TYPE 5B - FRAME CONSTRUCTION **DESIGN CRITERIA:** MIN. UNIFORM DISTRIBUTED LIVE LOADS (LBS./S.F.): FIRST FLOOR • 40 SECOND FLOOR • 40 THIRD FLOOR • 40 • 40 STAIRS ATTIC W/O STOR. • 10 • 20 ATTIC W/STOR. • 40 DECKS • 200 GUARDRAIL/ HANDRAIL ROOF 35 GROUND SNOW LOAD WIND SPEED: STANDARD LIGHT-FRAME CONSTRUCTION IN THIS 115 M.P.H. OCCUPANCY IS SUFFICIENT FOR THIS DESIGN CATAGORY SEISMIC DESIGN CATAGORY: STANDARD LIGHT-FRAME CONSTRUCTION IN THIS OCCUPANCY IS SUFFICIENT FOR THIS DESIGN CATAGORY

> NEW CONSTRUCTION IS NOT LOCATED IN AREA INDICATED AS 100 YEAR FLOOD PLAN AS PER NATIONAL RESOURCES, PREPARED BY

FLOOD HAZARD:

ACCESSORY APARTMENT: THE HOTCHKISS **SCHOOL**

270 SHARON ROAD LAKEVILLE, CT



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	_

1	SITE PLAN APPROVAL	03.15.23
#	ISSUE/REVISION	DATE

HEET NUMBER

SHEET TITLE: TITLE SHEET

AS NOTED 15 MARCH 2023

PROJECT NUMBER:

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ACCESSORY APARTMENT: THE HOTCHKISS SCHOOL

270 SHARON ROAD LAKEVILLE, CT




studio v A A 120 CHANNINGVILLE RD WAPPINGERS FALLS, NY 12590 T 914 475 0076

SITE PLAN APPROVAL 03.15.23 REVISION


CAMPUS SITE PLAN ENLARGED LOCAL SITE PLAN

SHEET NUMBER:

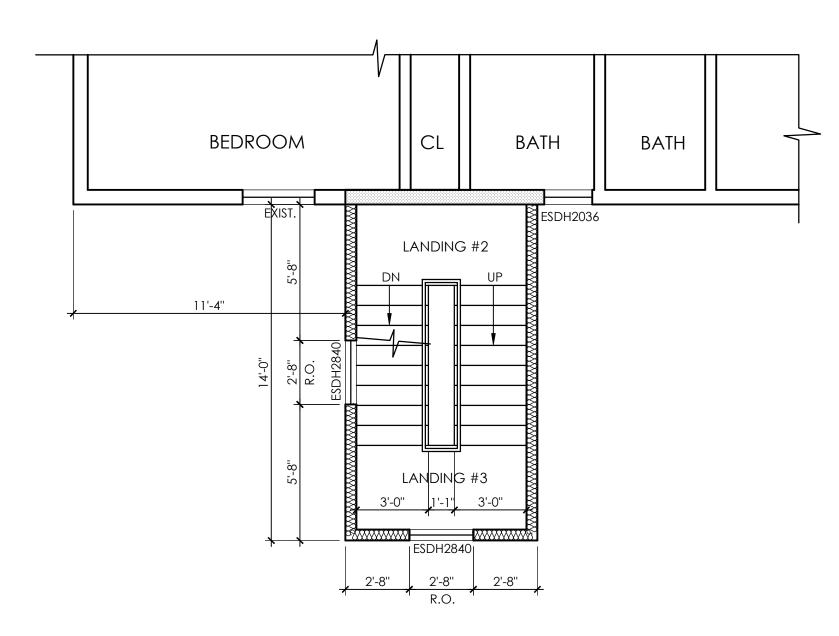


STAIR TOWER SECOND FLOOR PLAN

SCALE: 1/4" = 1'-0"

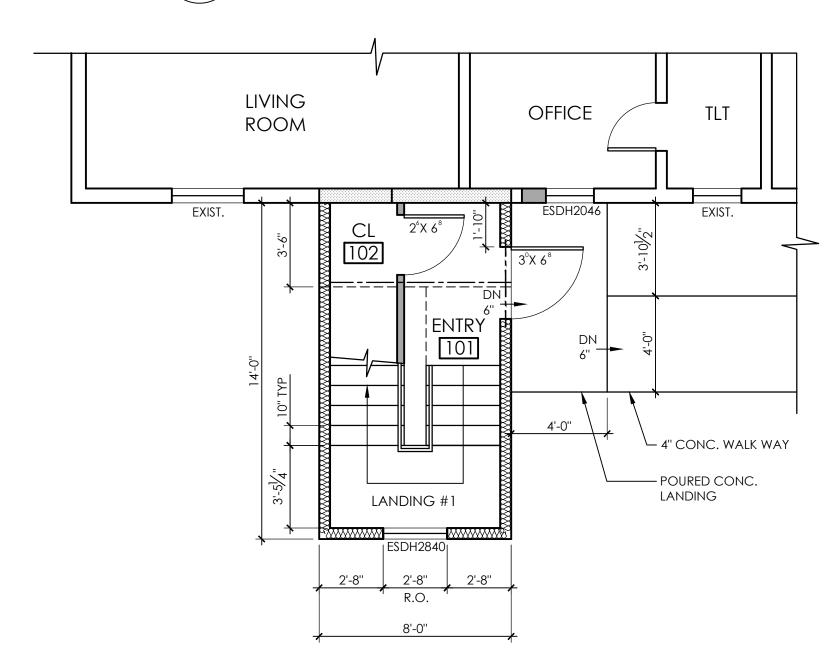


STAIR TOWER FFIRST FLOOR PLAN SCALE: 1/4" = 1'-0"

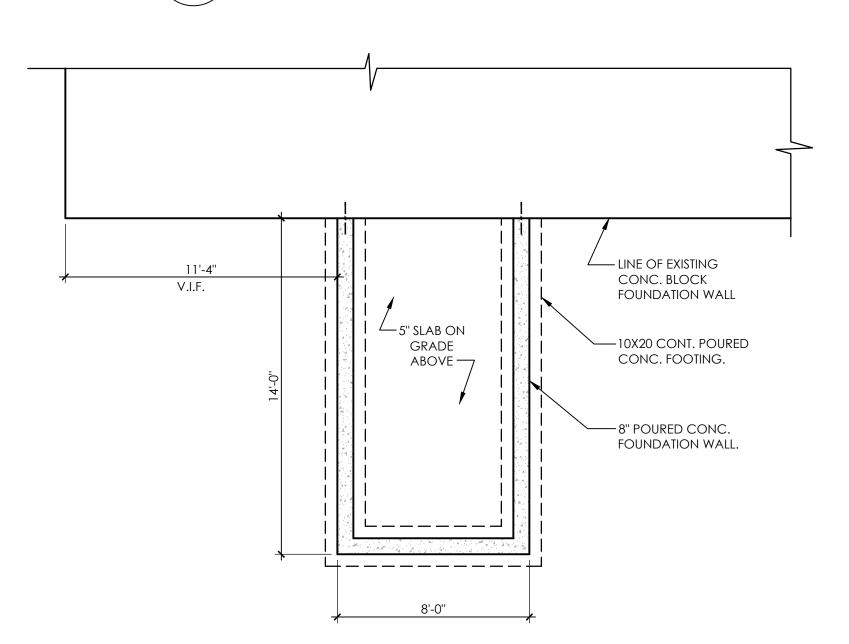


STAIR TOWER FOUNDATION PLAN

SCALE: 1/4" = 1'-0"

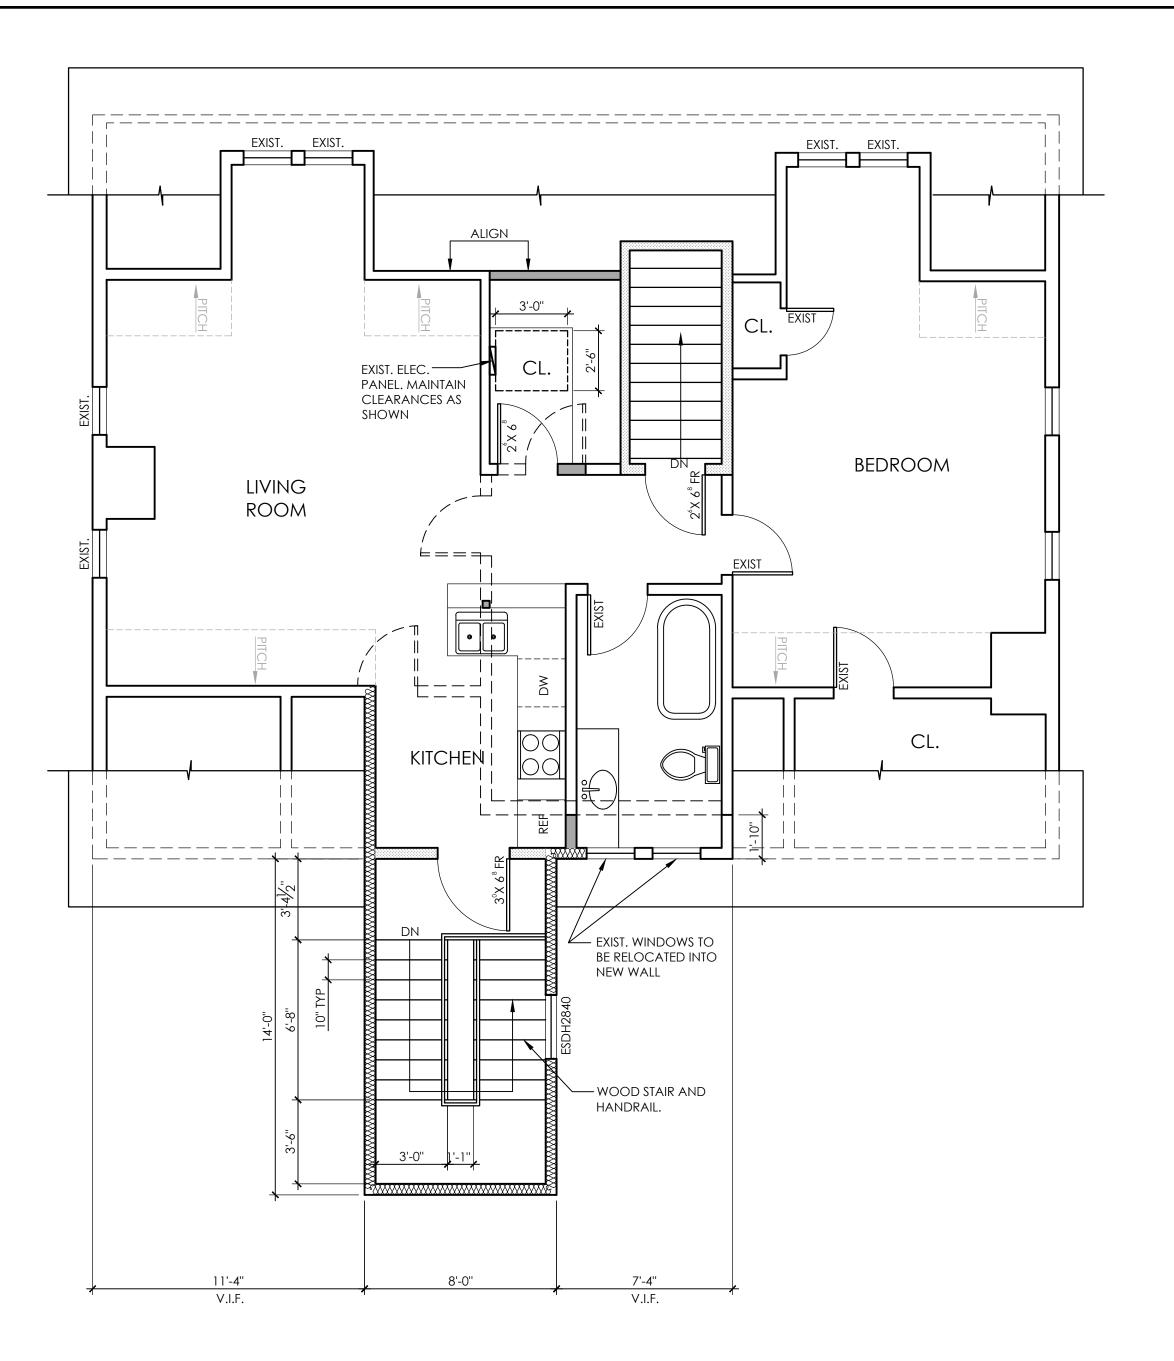

THIRD FLOOR PLAN SCALE: 1/4" = 1'-0"

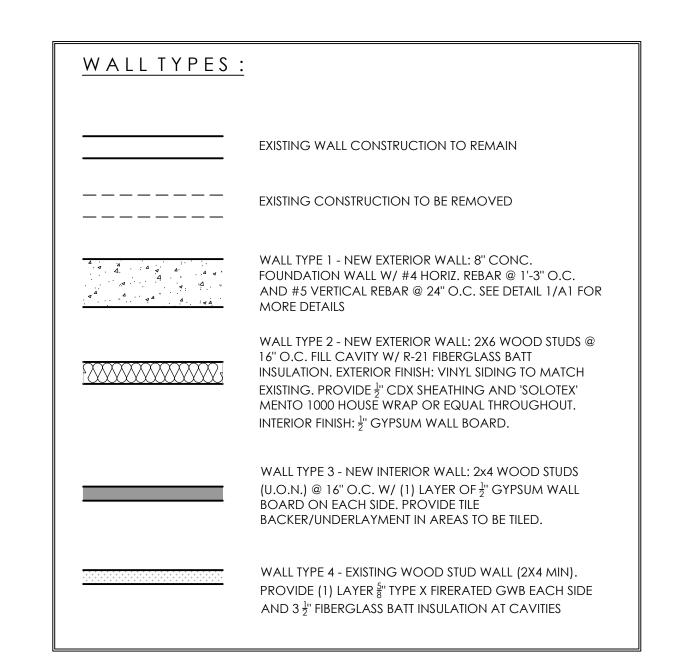

ACCESSORY APARTMENT: THE HOTCHKISS SCHOOL

270 SHARON ROAD LAKEVILLE, CT



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SITE PLAN APPROVAL 03.15.23 REVISION DATE

SHEET NUMBER:

FLOOR PLANS

AS NOTED

15 MARCH 2023 PROJECT NUMBER:

2301

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