

Conservation Commission

Town of Salisbury, Conservation Commission, Application for Regulated Activity Permit

1) Applicants name: BENJAMIN PALMER

2) Applicants home address: 1929 Greenwich Street, San Fransico, CA 94123

3) Applicants business address: 235 BELGO ROAD, SALISBURY, CT 06068

4) Applicants Home Phone #: 617-634-2649 Business Phone #: 617-634-2649

5) Owner of property: Name: 235 BELGO ROAD, LLC

Address: 235 BELGO ROAD, SALISBURY, CT 06068

Phone #: 617-634-2649

Signature of property owner consenting to this application:

6) Applicants interest in the land: OWNER

7) Geographical location of property: 235 BELGO ROAD, SALISBURY, CT 06068

Description of the land: 3.406 acres of farmland soil, meadows, trees with stream and vacant barn.

Gentle slope on eastern side 838' to 813'

Computation of wetland area or watercourse disturbance: Proposed renovation to interior side of barn only with

partial roof replacement, new siding and new windows

installation.

8) Purpose and description of the proposed activity: RENOVATION OF EXISTING BARN TO BE USED AS

A SINGLE FAMILY RESIDENCE

9) Alternatives considered by applicant: N/A

Why this proposal to alter wetlands was chosen: NO ALTERATION TO THE WETLANDS REQUIRED FOR THIS

PROJECT

10) Site plan showing existing and proposed conditions in relation to wetlands and watercourses:

(Attach map and plans to application)

11) Names and addresses of adjacent property owners:


North: Janowitz James & Katherine, 28 Indian Orchard Road

South: Hoffman Jon M Trustee, 34 Indian Orchard Road

East: Nadjek Donald, 241 Belgo Road

West: Hang with the Turkeys LLC, 245 & 251 Belgo Road

12)	Certification that the applicant is familiar with all the information provided in the application and is aware of the penalties for obtaining a permit through inaccurate or misleading information: Signature:						
13)	Authorization for the commissioners and agents of the Commission to inspect the property, a reasonable times, both before and after a final decision has been issued: Signature:						
14)	DEEP Reporting Form 22A-39-14 provided by applicant (Rev. 3/2013)						
15)	Any other information the Commission deems necessary to the understanding of what the applicant is proposing:						
16)	Section 7.6 Requirements, if stipulated by agent						
17)	Filing Fee: As defined in current Regulations						
18)	For activities involving a significant activity as determined by the Commission and defined in Section 2 of the regulations the provisions of Article 7.6 must be submitted with the application. (Attach documents).						
19)	If the affected property is within 500 feet of an adjacent municipality the applicant is responsible for providing documentation that the provisions of 8.9 of the regulations have been satisfied: (Attach documents).						
DA	TE FILED:06-05-2025						
DA	TE RECEIVED BY COMMISSION:						
AC	TION: a) INSIGNIFICANT ACTIVITY						
	CONDITIONS:						
	DATE OF APPROVAL:						
	b) SIGNIFICANT ACTIVITY						
	PUBLIC HEARING DATE:						
	PUBLIC HEARING DATE + 65 DAYS:						
СН	ECK LIST:						
A.	PUBLIC NOTICE: DATES PUBLISHED:						
B.	PROOF THAT APPLICANT HAS MAILED COPIES OF PUBLIC NOTICE TO ABUTTING PROPERTY OWNERS:						
C.	PROOF OF PROVISIONS OF SECTION 8.2 (IF APPLICABLE):						

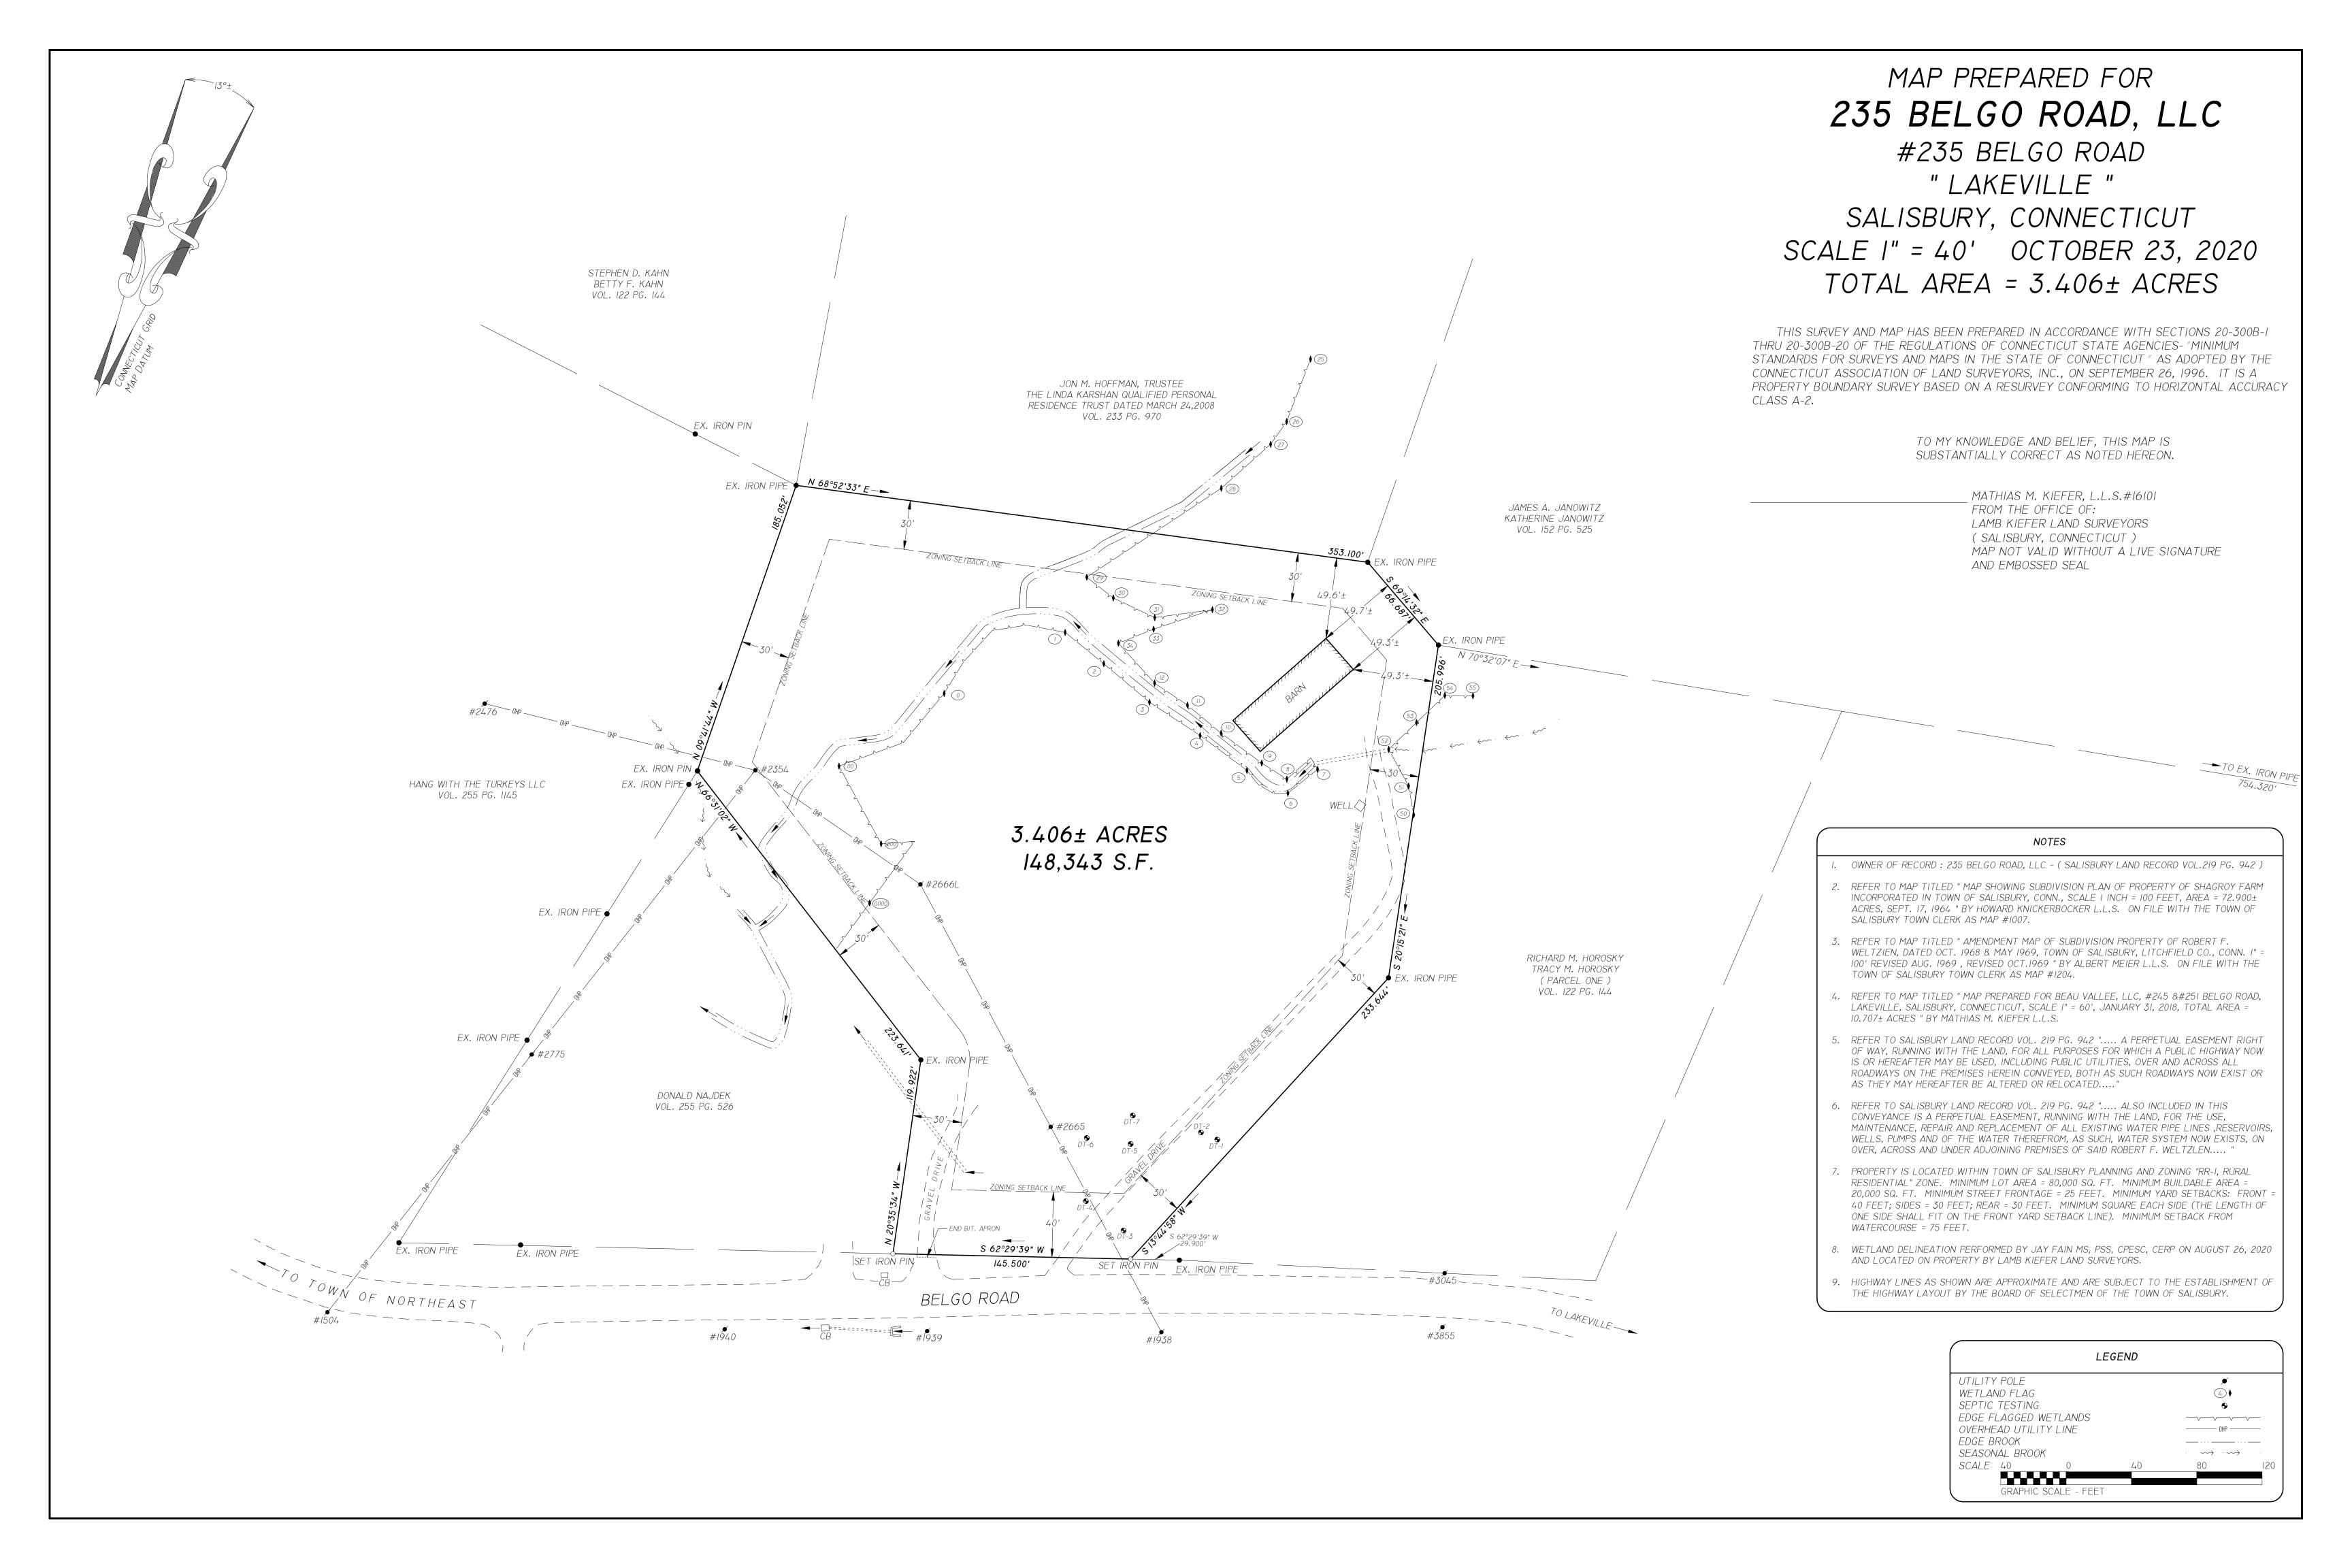

PROPERTY LINES AND GENERAL INFORMATION WAS TAKEN FROM MAP SUPPLIED BY LAMB KIEFER LAND SURVEYING. TOPOGRAPHIC INFORMATION WAS DETERMINED IN THE FIELD BY MAT KIEFER, LS

RATE IS 1" DROP PER 40 MINUTES, REQUIRING 900 SQUARE FEET OF EFFECTIVE LEACHING AREA. USING ONE ROW AT 96' OF GREENLEACH GLF 15.62 LEACHING SYSTEM EQUALS 96 LF AT 9.4 FT /FT, EQUALS 902.40 SQUARE FEET OF EFFECTIVE LEACHING AREA PROVIDED.

THROUGH 19-13-B103F, THE PRESCRIBED PRACTICES OF THE TORRINGTON AREA HEALTH DISTRICT AS WELL AS ACCEPTED STANDARDS OF GOOD WORKMANSHIP. INSPECTIONS:

THE ENGINEER OF RECORD PRIOR TO BACKFILLING. THE CONTRACTOR IS TO NOTIFY THE ENGINEER OF RECORD A MINIMUM OF 48 HOURS IN ADVANCE FOR THIS INSPECTION FOR SCHEDULING PURPOSES.

THE ENGINEER OF RECORD MUST PREPARE AN AS-BUILT PLAN OF THE COMPLETED SEWAGE DI SPOSAL SYSTEM. ADDI TI ONAL I NSPECTI ONS AT THE FOLLOWI NG STAGES OF CONSTRUCTION MAY ALSO BE REQUIRED:

- AFTER FILL IS IN PLACE, PRIOR TO INSTALLATION OF SEWAGE DISPOSAL SYSTEM SELECT FILL SPECIFICATIONS AND INSTALLATION PROCEDURES:

ALL SELECT FILL MATERIAL USED IN THE SEWAGE DI SPOSAL SYSTEM SHALL BE BANK-RUN GRAVEL HAVING A MINIMUM PERCOLATION RATE OF 1" DROP PER 5 MINUTES. SELECT FILL SHALL CONFORM TO THE FOLLOWING SPECIFICATION:

SHALL NOT CONTAIN MORE THAN 45 PERCENT GRAVEL (GRAVEL FALLS BETWEEN THE NO. 4 - 3" SEIVES). THE FILL, LESS GRAVEL SHALL MEET THE FOLLOWING

FROM A SAMPLE OF SELECT FILL, ALL MATERIAL LARGER THAN THE NO. 4 SEIVE (GRAVEL) SHALL BE REMOVED FROM THE SAMPLE AND DISCARDED. THE REMAINING PERCENT PASSING BY WEIGHT

PERCENT PASSING THE #100 SIEVE DOES NOT EXCEED 10% AND THE #200 SIEVE DOES NOT EXCEED 5%.

BEEN DELIVERED TO THE SITE AS WELL AS WHEN TESTED AT THE PIT OR OTHER

AND SPREAD ACROSS THE SCARIFIED AREA BY BULLDOZER. DUMP TRUCKS OR OTHER SIMILAR VEHICLES ARE PROHIBITED ON THE AREA OF THE SEWAGE DISPOSAL SYSTEM

THE RESPONSIBILITY OF STEVEN D. TRINKAUS, P.E. IS LIMITED TO THE DESIGN STEVEN D. TRINKAUS, P.E. ASSUMES NO COMPLIANCE WITH PLAN SPECIFICATIONS

NO CHANGES ARE PERMITTED TO THE LOCATION AND/OR ELEVATIONS OF THE SEWAGE

NOTE: THE DESIGN ENGINEER MUST INSPECT THE SCARIFICATION OF THE SOIL UNDER AND AROUND THE PROPOSED SEWAGE DISPOSAL SYSTEM PRIOR TO THE PLACEMENT OF THE SELECT FILL MATERIAL.

GENERAL NOTES:

MAPPI NG: BENCH MARK IS TOP OF NAIL AS SHOWN, ELEVATION EQUALS 834.93'.

A THREE BEDROOM (PROPOSED) RESIDENCE WITH ON-SITE WATER WELL. DESIGN PERCOLATION

ALL CONSTRUCTION ACTIVITIES AND DETAILS SHALL BE IN ACCORD WITH THE STATE OF CONNECTICUT DEPARTMENT OF HEALTH "PUBLIC HEALTH CODE" SECTIONS 19-13-B103A

AN INSPECTION OF THE COMPLETED SEWAGE DISPOSAL SYSTEM MUST BE PERFORMED BY

- AFTER SCARI FI CATION OF AREA HAS BEEN DONE, PRI OR TO FILL PLACEMENT

THE FILL SHALL NOT CONTAIN ANY MATERIAL LARGER THAN 3". THE FILL

MATERIAL SHALL CONFORM TO THE FOLLOWING SEIVE ANALYSIS. SQUARE MESH SEIVE

NO. 4 NO. 10 NO. 40 10 - 50 NO. 100 0 - 20 NO. 200 0 - 5

* PERCENT PASSING THE #40 SIEVE CAN BE INCREASED TO NO GREATER THAN 75% IF THE

THE GRADING PERCENTAGES SPECIFIED ABOVE SHALL APPLY TO THE MATERIAL AFTER IT HAS SOURCE OF SUPPLY.

THE MINIMUM LIMITS OF SELECT FILL SHALL CONFORM TO THOSE SHOWN ON THE SITE PLAN. THE SELECT FILL SHALL BE HARROWED INTO THE EXISTING GROUND SURFACE PRIOR TO THE INSTALLATION OF THE SEWAGE DISPOSAL SYSTEM. ONE DUMP TRUCK LOAD OF SELECT FILL SHALL BE DELIVERED TO THE SITE AND PLACED OUTSI DE AND ADJACENT TO THE SEWAGE DI SPOSAL SYSTEM FOR APPROVAL BY THE ENGINEER OF RECORD. THE ENGINEER MUST BE NOTIFIED A MINIMUM OF 24 HOURS IN ADVANCE FOR THIS INSPECTION.

ALL SELECT FILL MUST BE PLACED AT THE EDGE OF THE SEWAGE DI SPOSAL SYSTEM

OF THE ON-SITE SEWAGE DI SPOSAL SYSTEM. UNLESS STEVEN D. TRINKAUS, P.E. INSPECTS ALL PHASES OF THE SEWAGE DISPOSAL

DI SPOSAL SYSTEM WITHOUT THE PRIOR WRITTEN APPROVAL OF THE ENGINEER OF RECORD.

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Belgo Road Isbury - Conn PREPABEN 1235 ESSABISE

PERCOLATION TEST: PT - G PERCOLATION TEST: PT - C PERCOLATION TEST: PT - E PERCOLATION TEST: PT - A DEPTH = 27" DEPTH = 18" DEPTH = 17" DEPTH = 24" PRESOAK AT 11 AM PRESOAK AT 10 AM PRESOAK AT 10 AM PRESOAK AT 9 AM TIME READING TIME READING TIME READING TIME READING 1:00 6" 11:05 12" 12:30 15" 12:00 4" 1:10 9" 12:10 7" 11:15 15" 12:50 16-1/2" 1:20 10-1/2" 12:20 8-1/2" 11:25 16" 1:30 11-1/2" 1:00 17" 11:35 16-1/2" 12:30 10" 17-3/8" 1:40 12" 1:10 12:40 11" 11:45 17" 1:50 12-1/2" 1:20 17-5/8" 12:50 11-1/2" 11:55 17-3/8" 2:00 12-7/8" 1:30 17-7/8" 1:00 12" 12:05 17-3/4" 1" DROP PER 26.6 MINUTES 1:40 18-1/8" 1:10 12-1/2" 12:15 18-1/8" 1" DROP PER 20 MINUTES 1" DROP PER 40 MINUTES 1" DROP PER 26 MINUTES PERCOLATION TEST: PT - B PERCOLATION TEST: PT - F PERCOLATION TEST: PT - D DEPTH = 22" DFPTH = 28" DEPTH = 17" PRESOAK AT 9 AM PRESOAK AT 10 AM PRESOAK AT 10 AM TIME READING TIME READING TIME READING 11:07 10" 12:35 17" 12:02 4" 11:17 12-3/4" 12:45 17-1/2" 12:12 7-1/4" 11:27 14-1/4" 12:55 18" 12:22 9" 11:37 14-3/4" 1:05 18-1/2" 12:32 9-3/4" 11:47 15-1/8" 1:15 18-7/8" 12:42 10-1/4" 11:57 15-1/2" 1:25 19-1/8" 12:52 10-3/4" 12:07 15-7/8" 1:35 19-3/8" 1:02 11-1/8" 12:17 16-1/4" 1:45 19-5/8" 1:12 11-1/2" 1" DROP PER 26 MINUTES 1" DROP PER 40 MINUTES 1" DROP PER 26.6 MINUTES

16 - 26" PALE YELLOW BROWN, LIGHT BROWN SILT LOAM

NO MOTTLING AT 26" (NATIVE SOIL PROFILE)

PERCOLATION TESTS PT - E & PT - F WERE

PERFORMED ON 12/10/20

2" MAXIMUM COVER. IF DEEPER, PROVIDE FINISH GRADE **□DI AMETER** □DI AMETER MANHOLE MANHOLE → OUTLET APPROVED NON-BY-PASS MI D-DEPTH ONNECTI ON 1/3 REQUIRED 2/3 REQUIRED TYPI CAL SEPTI C TANK

ATTACH FILTER FABRIC SECURELY TO UPSTREAM SIDE OF POST 10' (3m) MAXIMUM SPACING WITH WIRE SUPPORT FENCE 6' (1.8m) MAXIMUM SPACING WITHOUT WIRE SUPPORT FENCE FLOW 12" MIN. \ (300mm) / TRENCH DETAIL INSTALLATION WITHOUT TRENCHING NOT TO SCALE 2. INSPECT AND REPAIR FENCE AFTER EACH STORM EVENT AND REMOVE SEDIMENT WHEN NECESSARY. 9" (225mm) MAXIMUM RECOMMENDED STORAGE HEIGHT. SILT FENCE

__ FILTER_FABRIC STRAW BALES, SANDBAGS, OR CONTINUOUS BERM OF <u>PLAN</u> GRAVEL CONSTRUCTION ENTRANCE/EXIT

0 - 24" SILTY SAND AND GRAVEL 24 - 77" GREY BROWN SILTY COMPACT HARDPAN LEDGE > 77", NO ROOTS, MOTTLING AT 24, WATER AT 48" 0 - 24" BROWN SAND AND GRAVEL 24 - 77" GREY BROWN SILTY COMPACT SAND AND GRAVEL LEDGE > 77", NO ROOTS, NO MOTTLING, WATER AT 64"

UNDER SUPERVISION OF TAHD

0 - 11" GRAY GRAVEL 11 - 19" BROWN SAND AND GRAVEL 19 - 24" GREY BROWN SAND AND GRAVEL 24 - 80" GREY BROWN SILTY MEDIUM COMPACT SAND AND GRAVEL LEDGE > 80", NO ROOTS, MOTTLING AT 24", WATER AT 54"

0 - 6" GRAY GRAVEL 6 - 16" BROWN SAND AND GRAVEL 16 - 24" GREY BROWN SAND AND GRAVEL 24 - 80" GREY BROWN SILTY MEDIUM COMPACT SAND AND GRAVEL LEDGE > 80", NO ROOTS, MOTTLING AT 24", WATER AT 34"

ADDITIONAL DEEP TEST HOLES EXCAVATED ON JANUARY 22, 2021

0 - 18" TOPSOIL

MINIMUM LEACHING SYSTEM SPREAD CALCULATION:

4. MLSS (REQ) = 26 * 2.0 * 1.50 = 78.0', MLSS (PROP) = 96.0'

3. THREE BEDROOMS, FF = 1.50

1. SLOPE = 13.7%, DEPTH TO RESTRICTIVE LAYER = 24", HD = 26 2. PERCOLATION RATE = 1" DROP PER 40 MINUTES, PF = 2.0

HH - 1B (2/3/21)

0 - 16" TOPSOIL

18 - 24" PALE YELLOW BROWN VERY FINE SAND AND SILT LOAM 24 - 70" GREY BROWN LIGHTLY COMPACT SILTY HARDPAN LEDGE > 70", ROOTS TO 24", MOTTLING AT 24"

21 - 34" PALE YELLOW BROWN VERY FINE SAND AND SILT LOAM 34 - 76" GREY BROWN LIGHTLY COMPACT SILTY HARDPAN LEDGE > 76", ROOTS TO 34", MOTTLING AT 34"

17 - 26" PALE YELLOW BROWN VERY FINE SAND AND SILT LOAM 26 - 80" GREY BROWN LIGHTLY COMPACT SILTY HARDPAN LEDGE > 80", ROOTS TO 40", MOTTLING AT 26"


UNDERGROUND ELECTRICAL WIRING PER STATE AND LOCAL CODES 2" SCHEDULE "40" PVC PIPE TO LEACHING SYSTEM — 4.4 NOTE: PUMP CHAMBER TO BE WATERPROOFED TO PREVENT THE INTRUSION OF GROUNDWATER OR SURFACE WATER PUMP CHAMBER DETAIL NOT TO SCALE


PUMP INFORMATION: USE A GOULDS MODEL #3871, SERIES EP 0412 (4/10 HP, 230V) OR APPROVED EQUI VALENT, SET FOR 12" DRAWDOWN. PUMP CHAMBER TO BE EQUI PPED WITH AN ALARM WHICH WILL SOUND IN THE HOUSE IN THE EVENT OF PUMP FAILURE. ALL ELECTRICAL ACTIVITIES AND DETAILS SHALL BE PERFORMED IN ACCORD WITH ALL STATE AND LOCAL CODE REQUIREMENTS, AS WELL AS THE MANUFACTURER'S SPECIFICATIONS. NO A.B.S. PIPE SHALL BE USED.


THIS IS TO CERTIFY THAT THE DESIGNOF THIS SEWAGE DI SPOSAL SYSTEM CONFORMS TO ALL STATE AND LOCAL SANITARY CODE REQUIREMENTS, AS WELL AS STANDARD PROFESSIONAL ENGINEERING DESIGN PRINCIPLES. IT IN NO WAY IS A GUARANTEE AGAINST FAILURE DUE TO INDETER-MI NABLE FUTURE CIRCUMSTANCES OR NATURAL PHENOMENON BEYOND THE SCOPE OF NORMAL FIELD INVESTIGATION.

IT IS THE RESPONSIBILITY OF THE CONTRACTOR TO CALL "CALL-BEFORE-YOU-DIG" AT 1-800-922-4455 AT LEAST TWO WORKING DAYS PRIOR TO THE COMMENCEMENT OF CONSTRUCTION FOR THE LOCATION OF ANY UNDERGROUND UTILITIES ON THIS PROPERTY.

NOTE: ALL SOLID DISTRIBUTION PIPE FROM THE SEPTIC TANK TO AND WITHIN THE SEWAGE DI SPOSAL SYSTEM SHALL BE ASTM D3034, SDR. 35, 4" PVC.

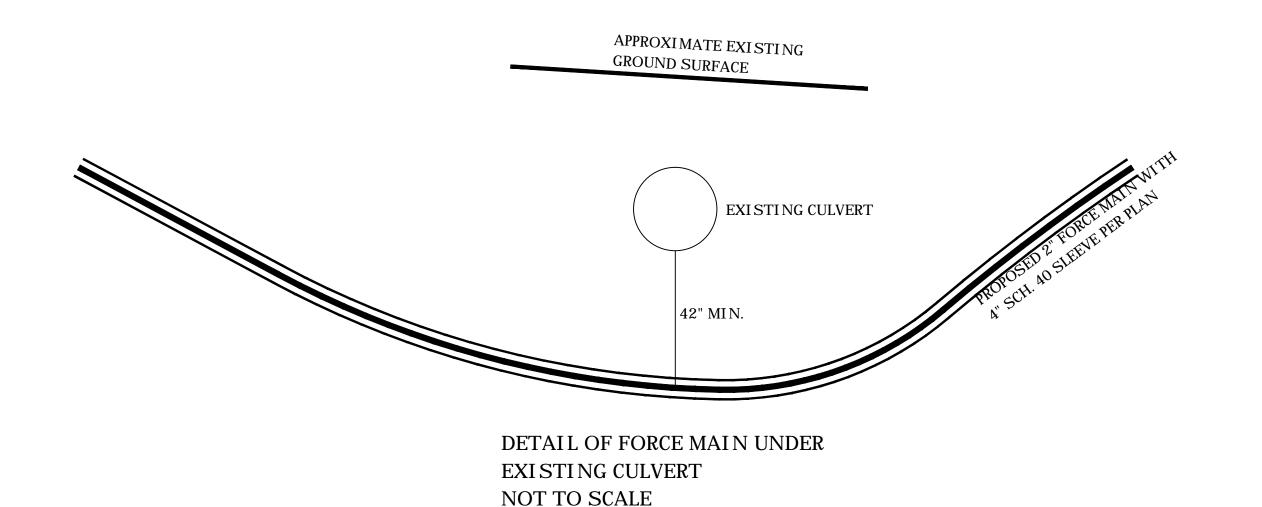

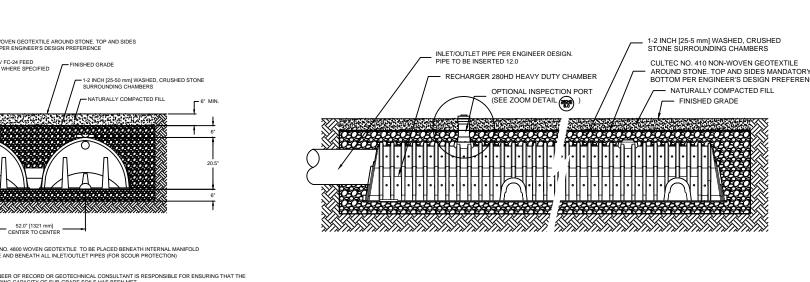

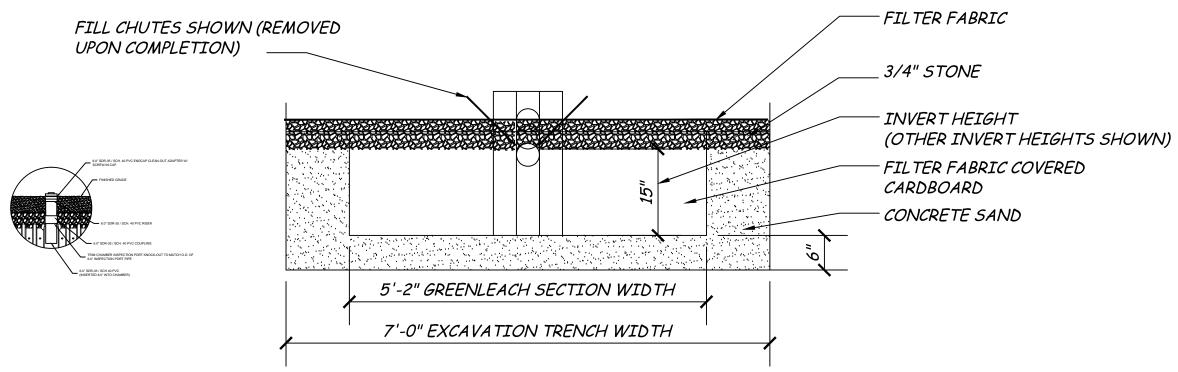



GLF 15-62 GREENLEACH SYSTEM SECTION - END VIEW


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GENERAL CONSTRUCTION NOTES:

1 ALL NEW WALL AND CEILING TO RECEIVE 1/2" GYP. BD, TAPE AND SPACKLE 2 COATS PLUS POLISH TO MAKE READY FOR PAINT.

2 ALL NEW TILE FLOOR SHALL BE THIN—SET OVER 1/2"
CEMENT BOARD AND SECURED TO PLY WITH CONTACT CEMENT AND SCREW AT 8" X 8" O.C. EACH WAY. ALTERNATIVELY, INSTALL TILE OVER UNCOUPLING MEMBRANE OVER PLYWOOD SUBFLOOR AND WATERPROOFING.

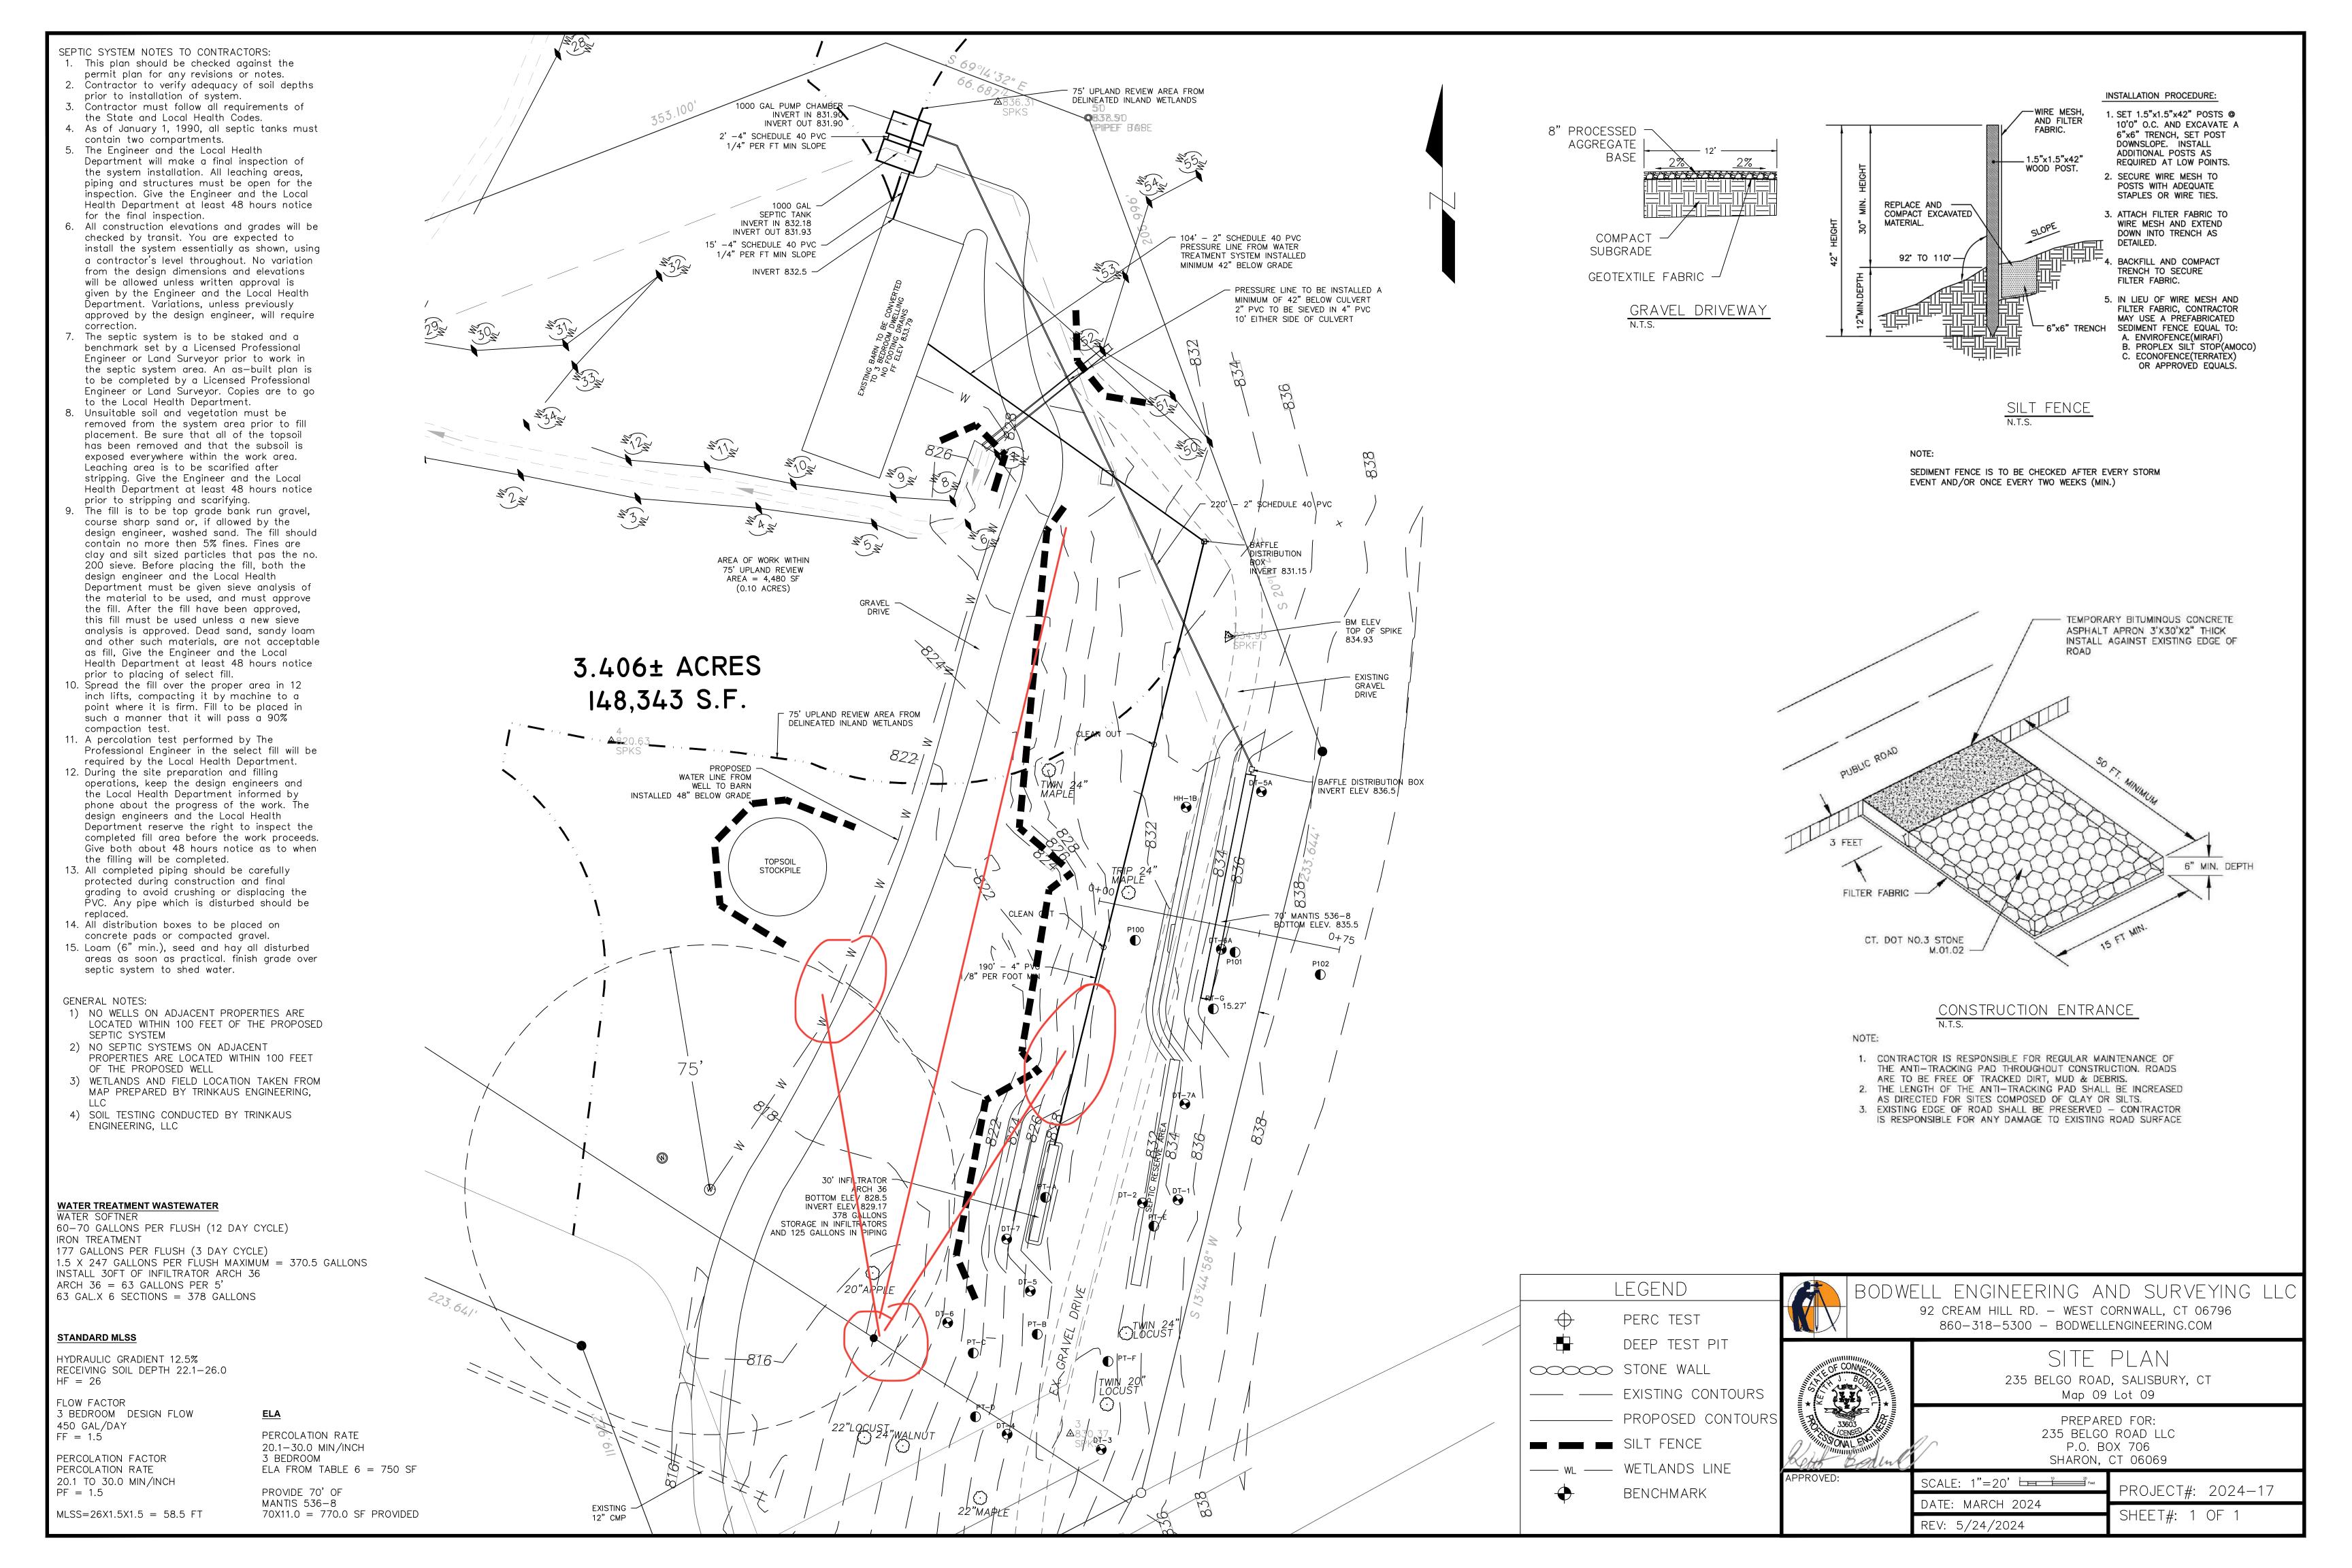3 ALL NEW ELECTRICAL AND HVAC WORK TO BE COORDINATED WITH G.C. AND SUB—CONTRACTORS.

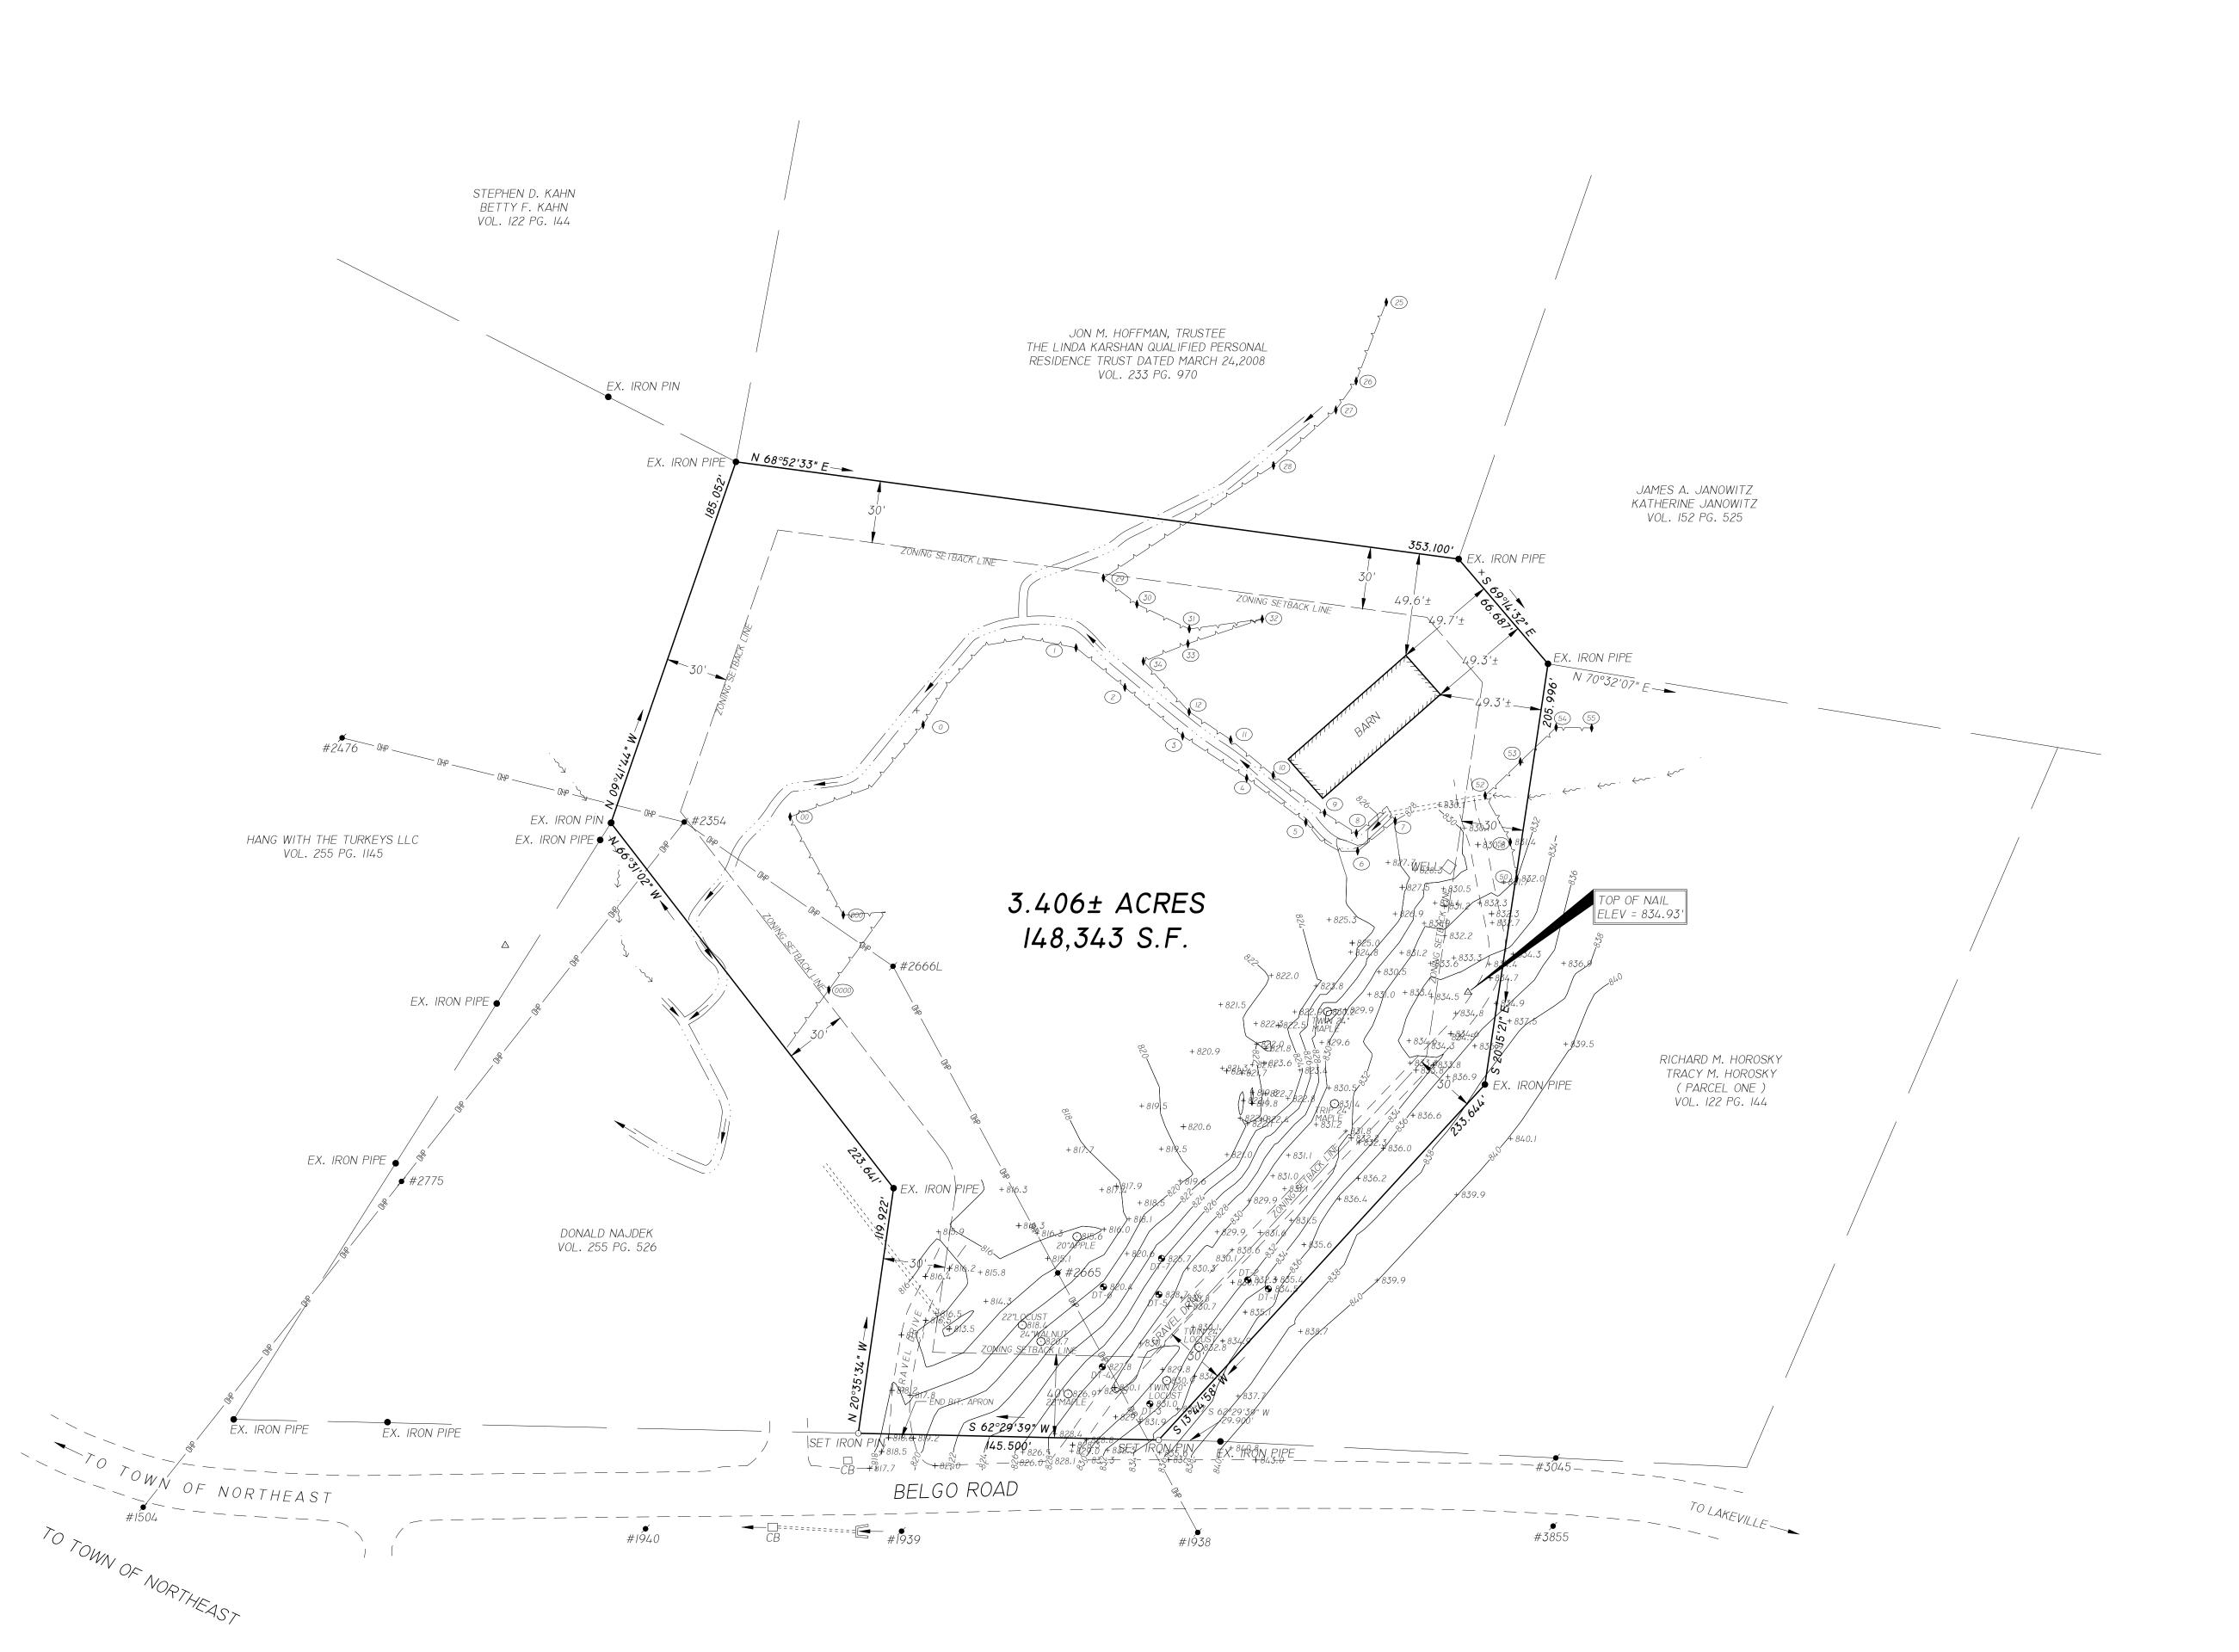4 ALL NEW INTERIOR WALLS TO BE 2X4 WITH (1) LAYER OF 1/2" GWB ON EACH SIDE, U.O.N.

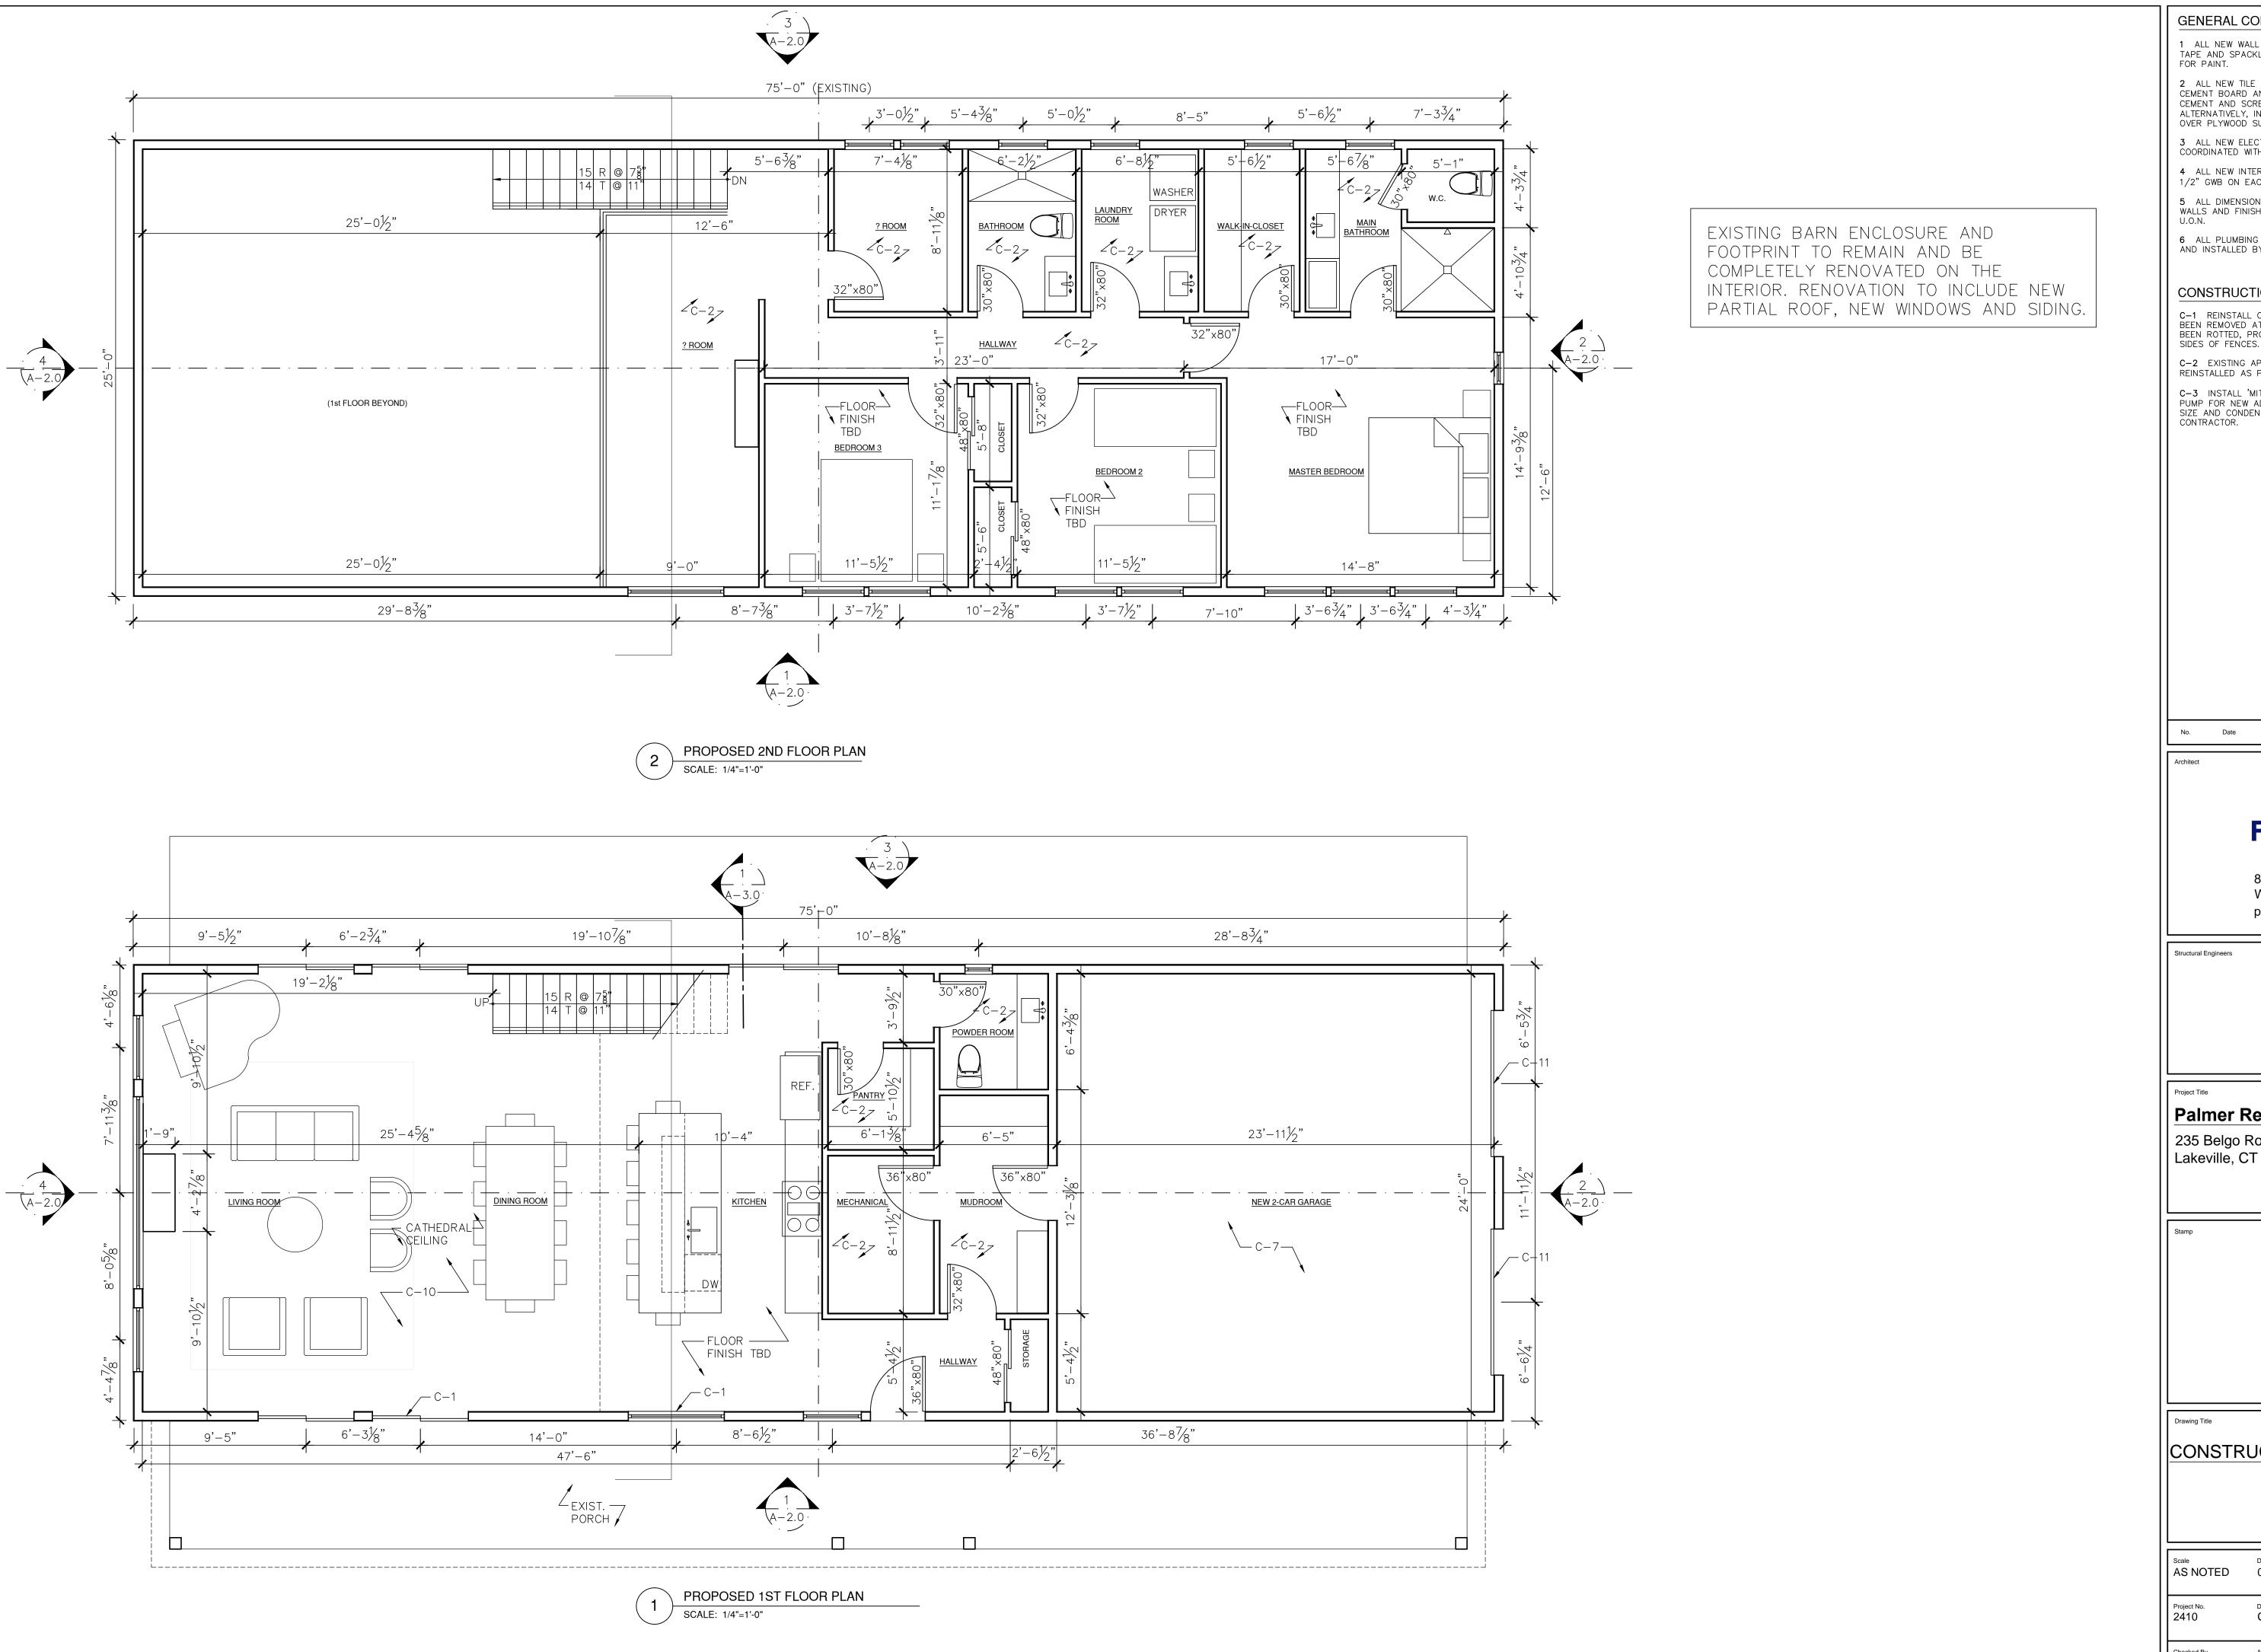5 ALL DIMENSIONS ARE GIVEN TO ROUGH FRAMING FOR NEW WALLS AND FINISHED SURFACES FOR EXISTING WALLS —

6 ALL PLUMBING FIXTURES TO BE PURCHASED BY OWNER AND INSTALLED BY G.C.

CONSTRUCTION NOTES:

C-1 REINSTALL ORIGINAL WOOD PICKET FENCE THAT HAS BEEN REMOVED AT DEMOLITION, REPLACE PIECE THAT HAS BEEN ROTTED, PROVIDE FRESH COAT OF PAINT ON BOTH SIDES OF FENCES.

C-2 EXISTING APPLIANCES TO BE REMOVED, STORED AND REINSTALLED AS PER OWNER'S DIRECTIONS.

C-3 INSTALL 'MITSUBISHI' HYPER-HEAT MINI SPLIT HEAT PUMP FOR NEW ADDITION HEATING AND COOLING. SYSTEM SIZE AND CONDENSER UNIT LOCATION T.B.D. BY HVAC CONTRACTOR.



Revision


8 Wright Street, #107 Westport, CT 06880 ph 203 . 682 . 2347

Palmer Residence

235 Belgo Road Lakeville, CT 06039

CONSTRUCTION PLANS

A-1.0 Drawn By CO/BW Plan North

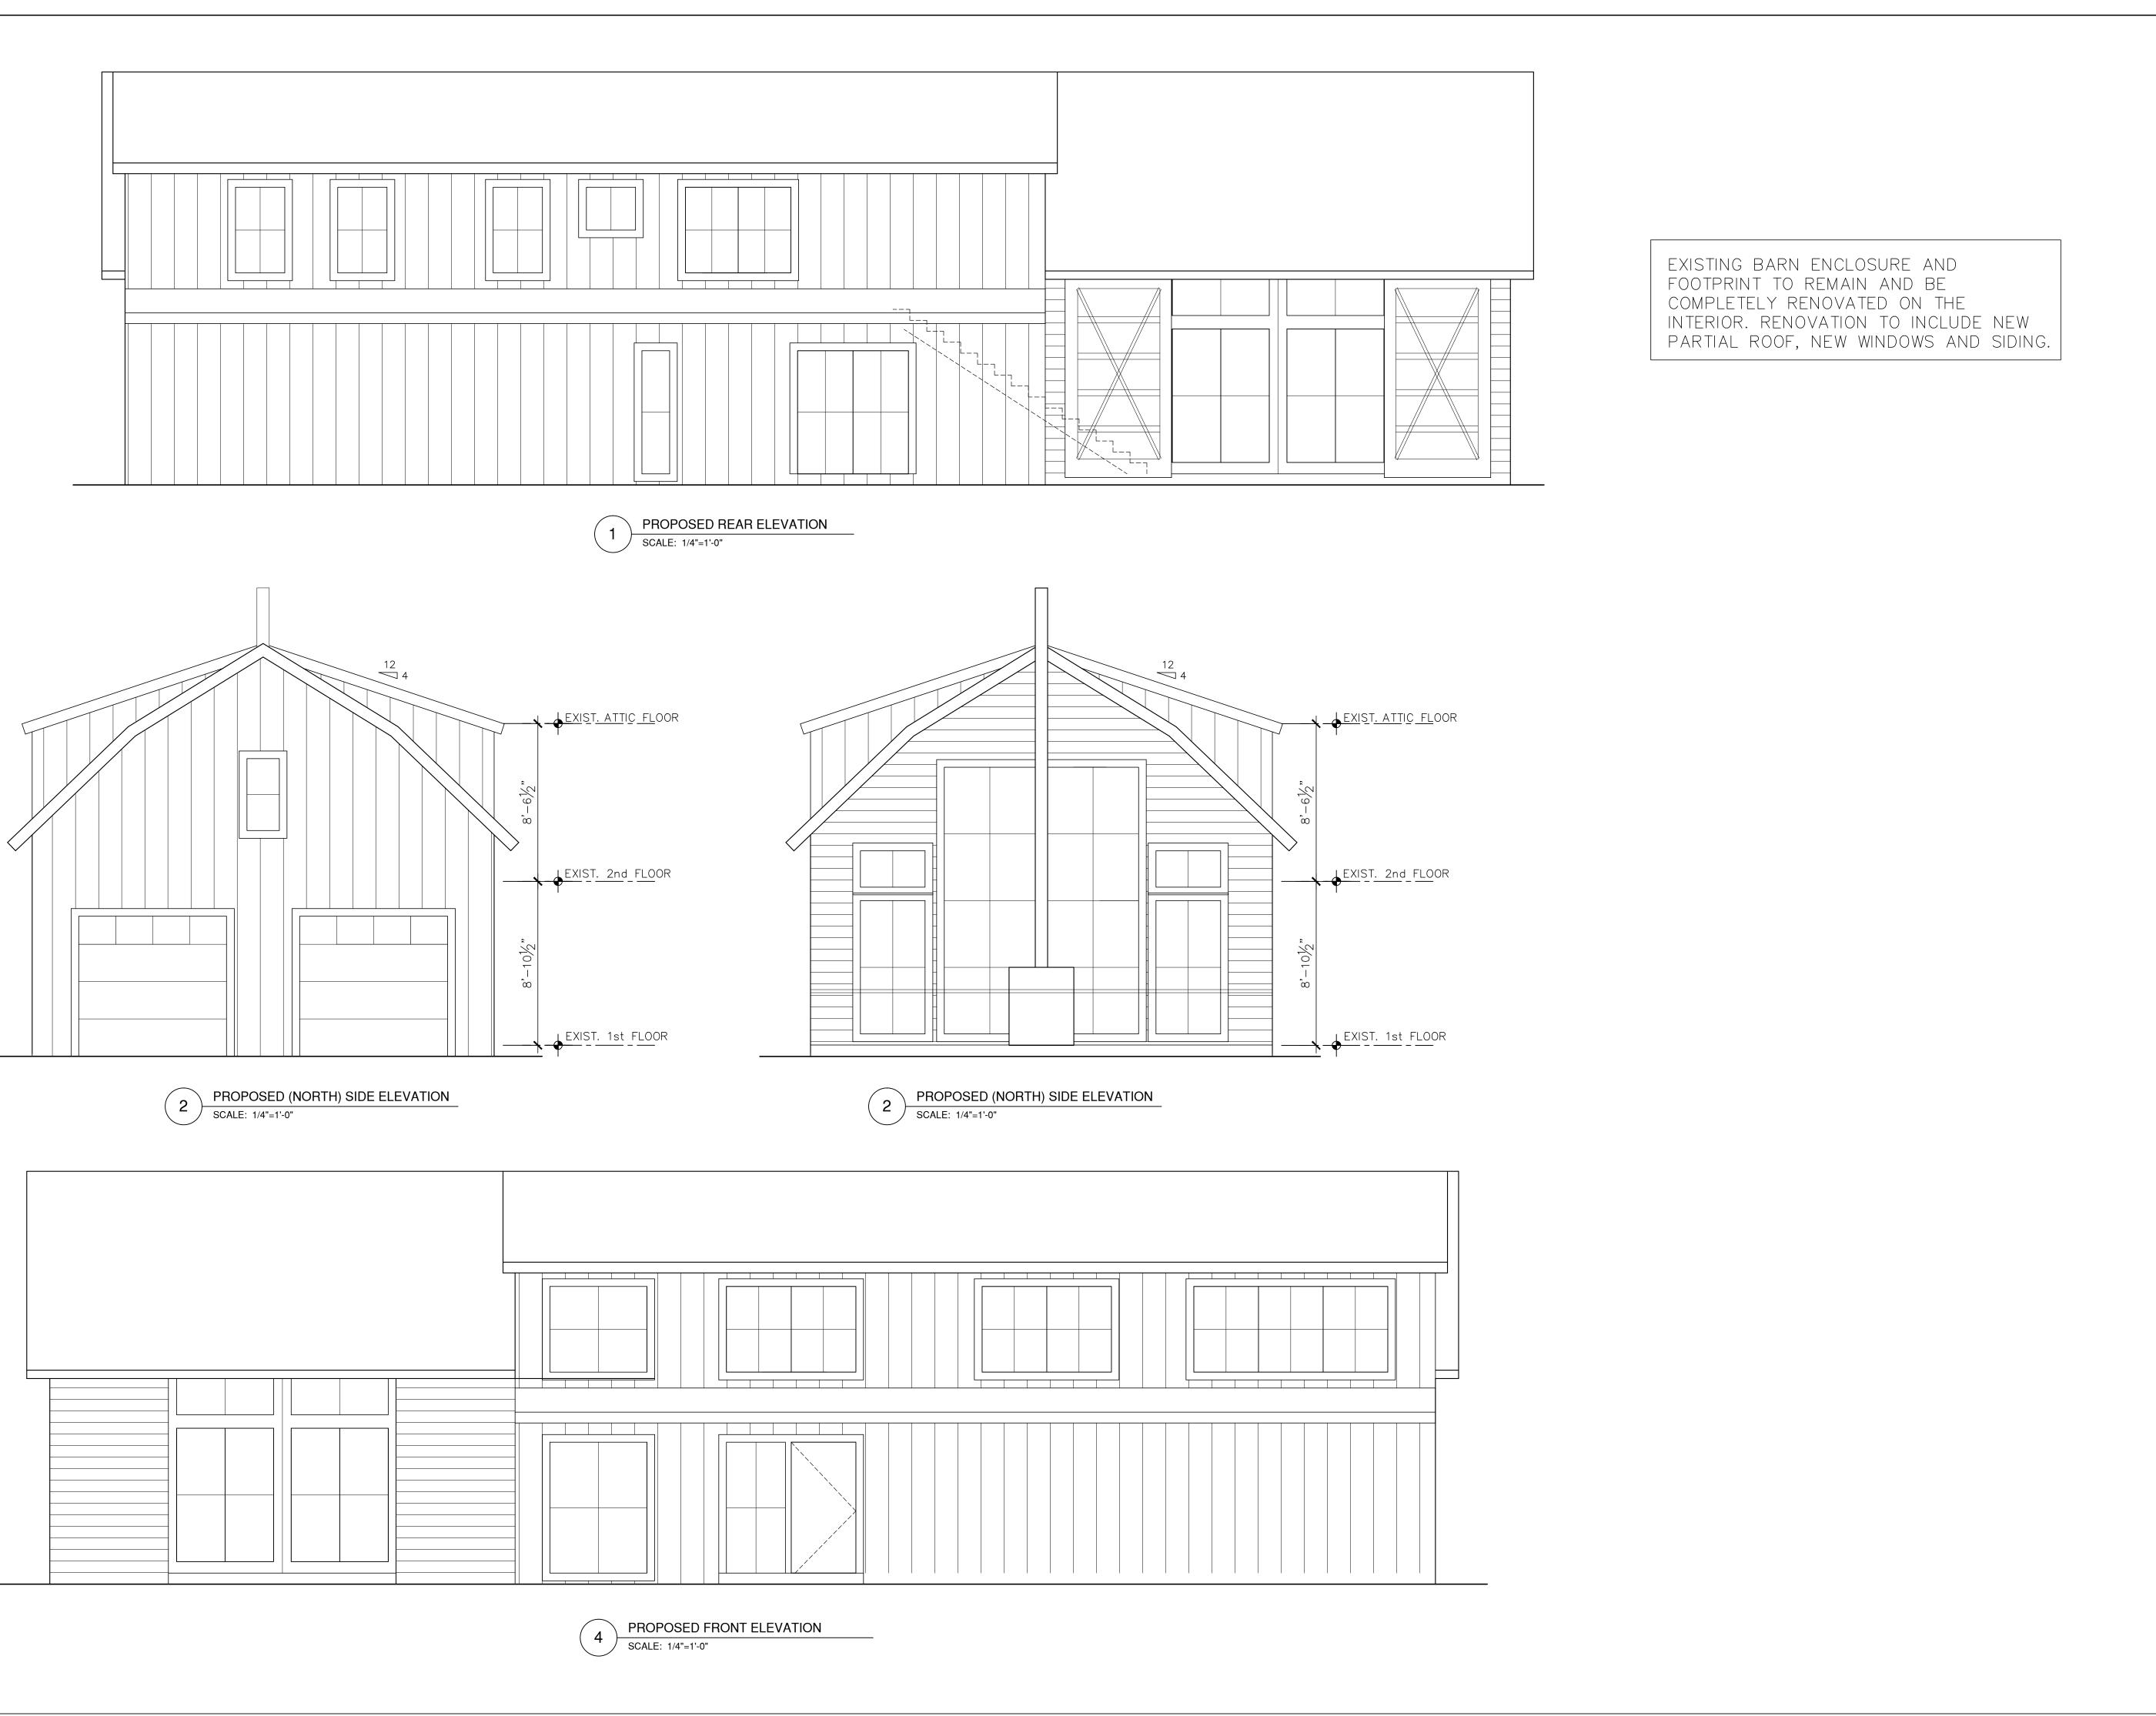

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lo. Date



8 Wright Street, #107 Westport, CT 06880 ph 203 . 682 . 2347

Structural Engineers		

Project Title

Palmer Residence

235 Belgo Road Lakeville, CT 06039

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Drawing Titl

EXTERIOR ELEVATIONS

Scale AS NOTED	Date 05-21-25	Sheet
Project No. 2410	Drawn By	A-2.0
Checked By	Approved By	Plan North